



Proposed North Elevation
Scale 1 : 200

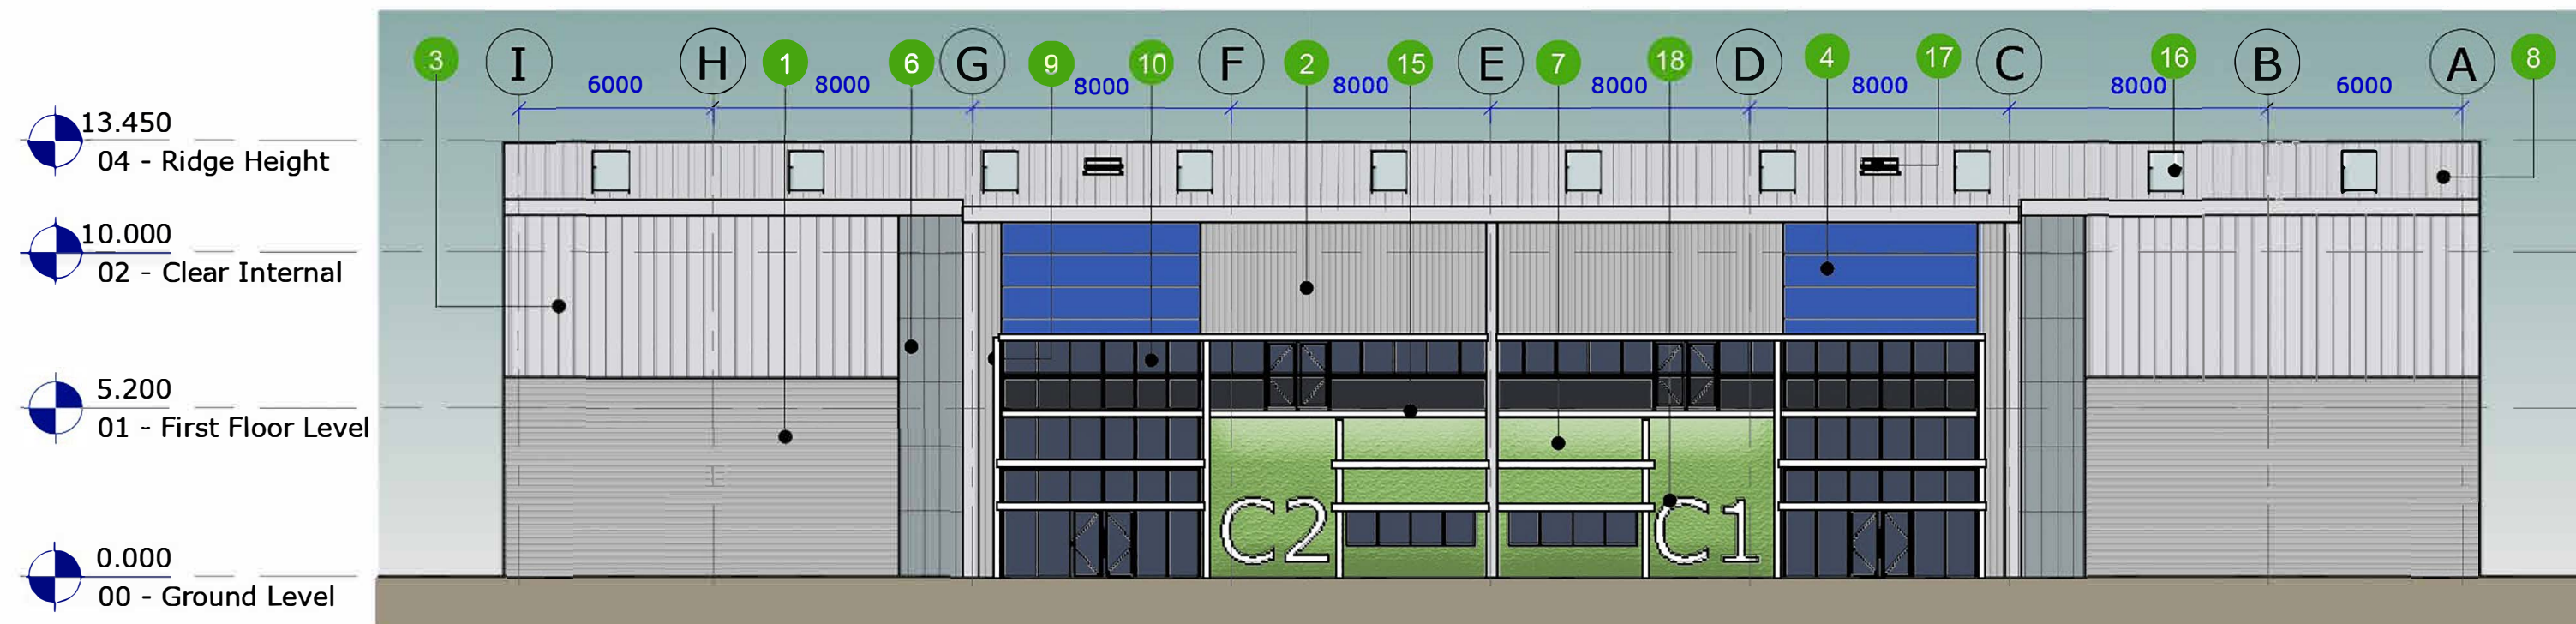


Proposed East Elevation
Scale 1 : 200


6. A elevations

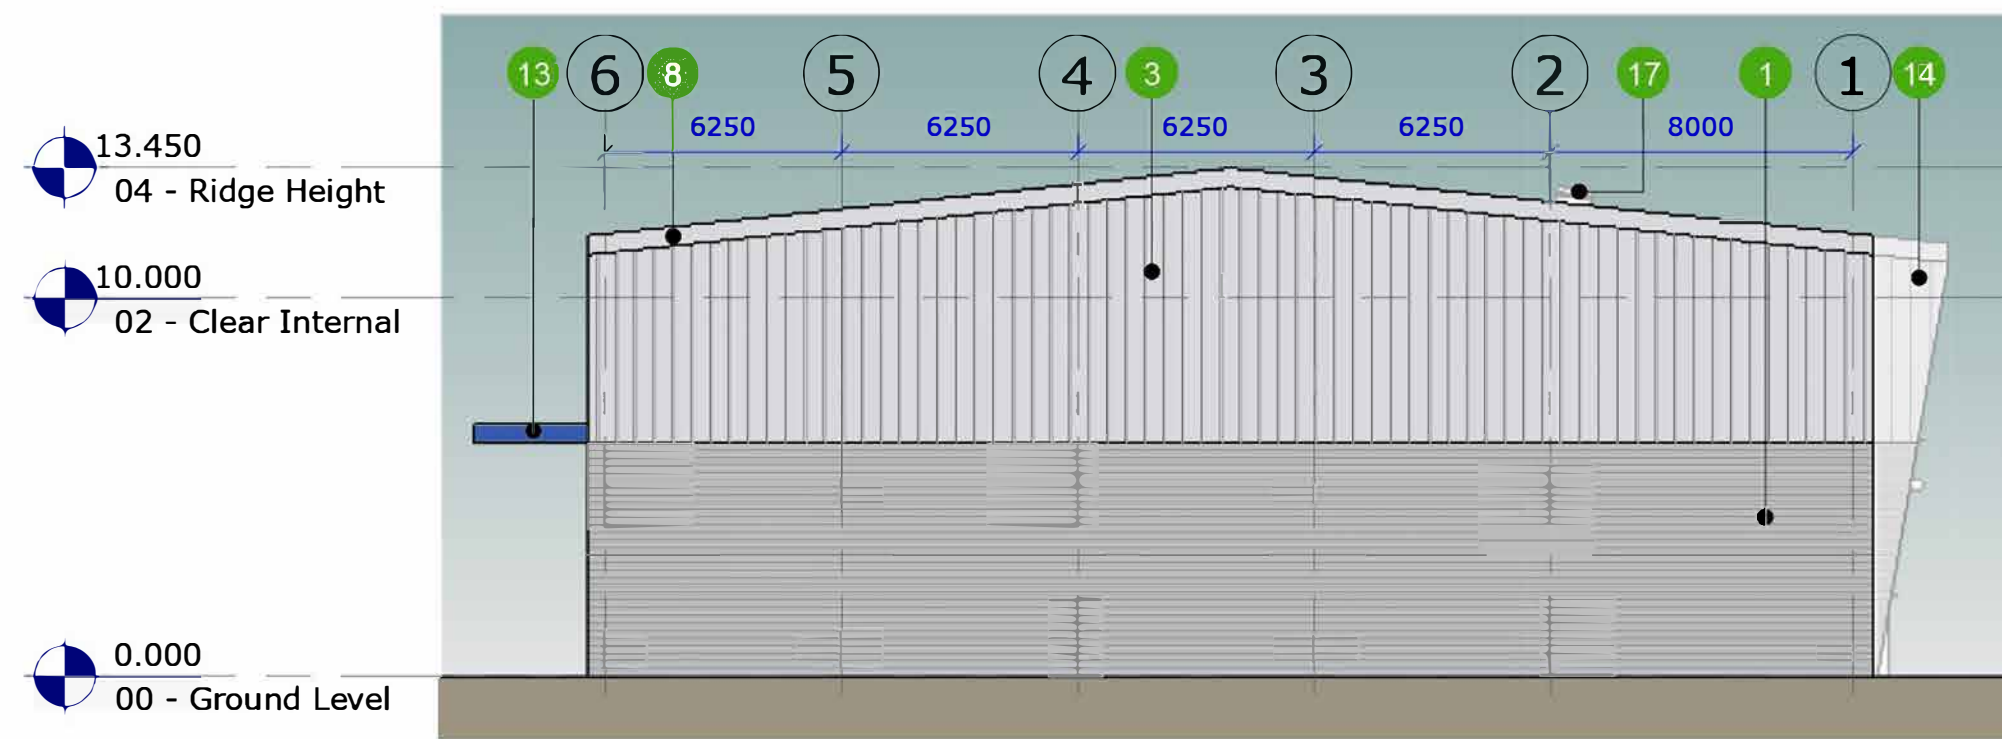

Proposed South Elevation
Scale 1 : 200

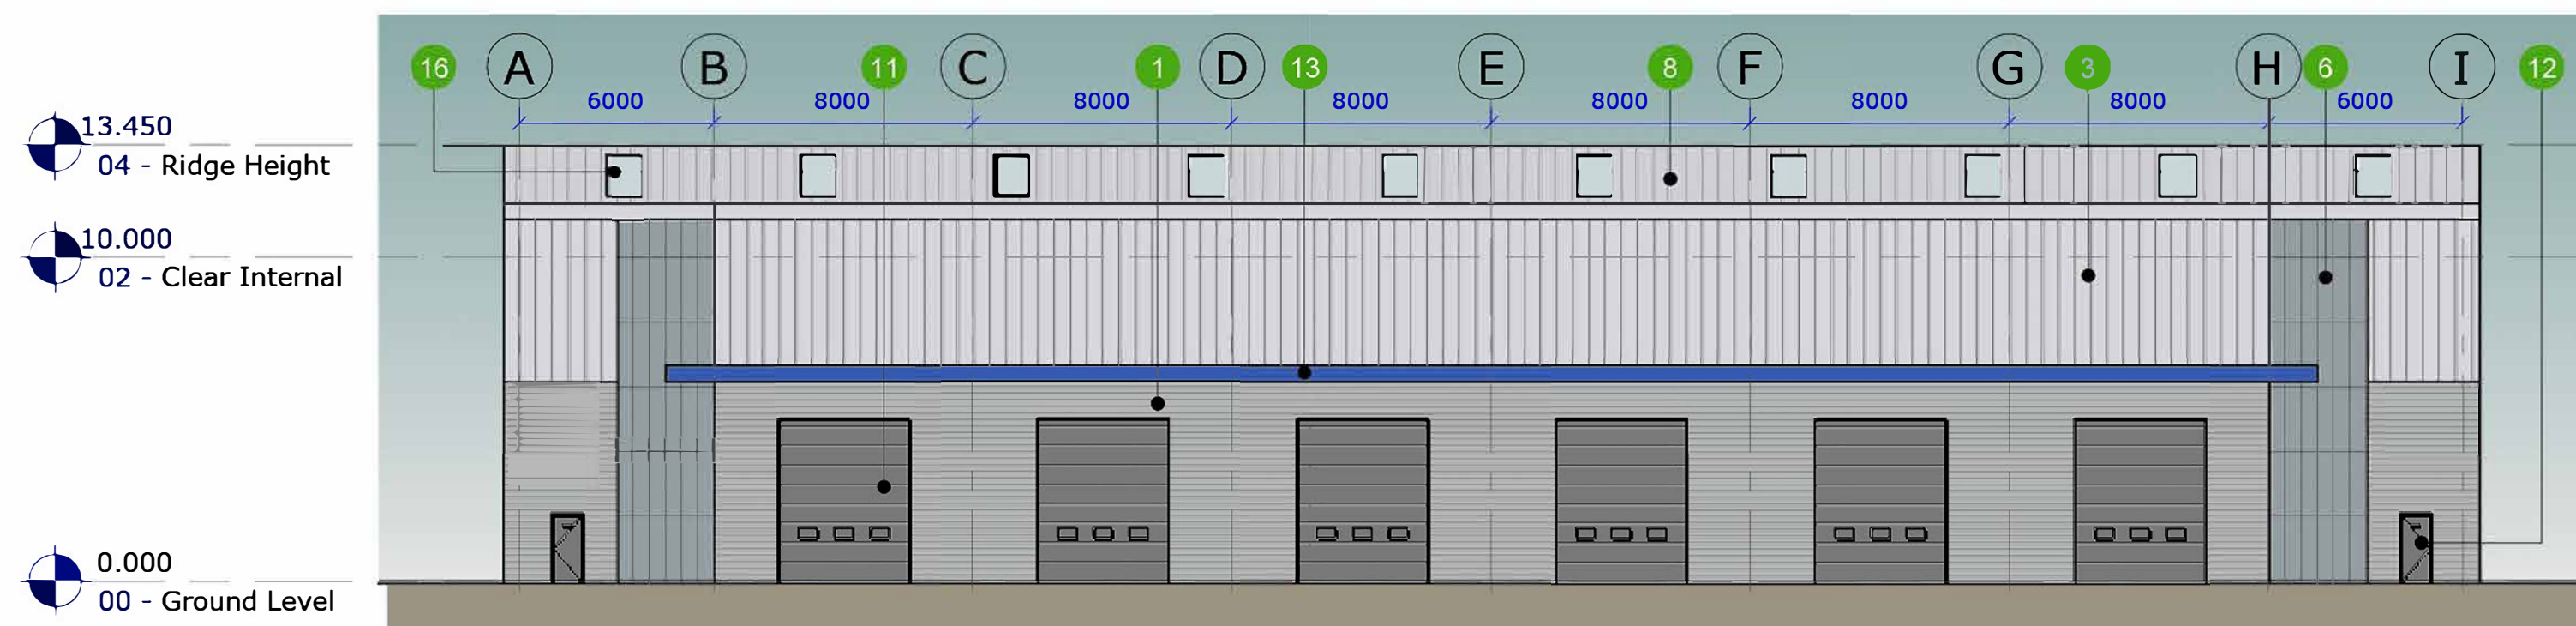

Proposed West Elevation
Scale 1 : 200

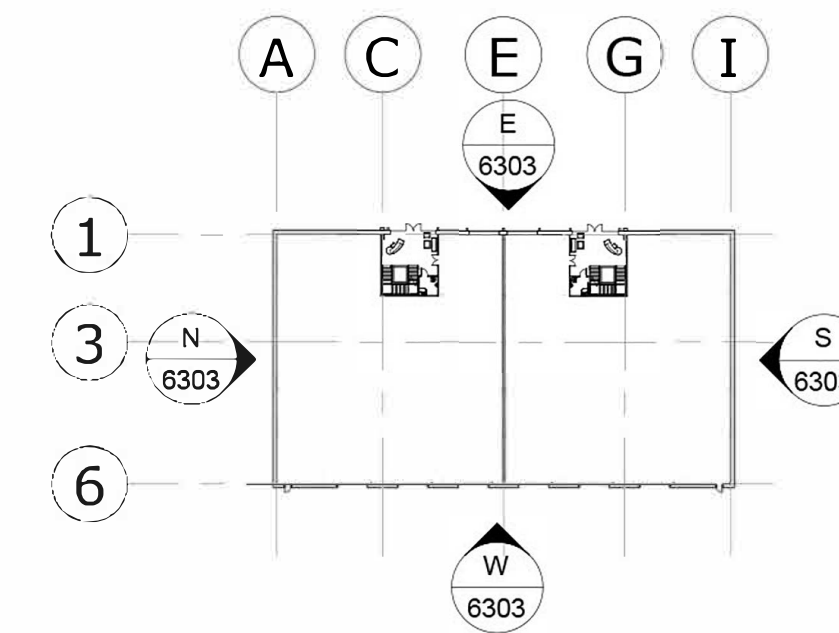

Key Plan
Scale 1 : 1000

- NOTES:
1. If this drawing has been received electronically it is the recipients responsibility to print the document to the correct scale.
 2. All dimensions are in millimetres unless stated otherwise. It is recommended that information is not scaled off this drawing.
 3. This drawing should be read in conjunction with all other relevant drawings and specifications.

- Schedule of Materials:
- 1 Trapezoidal horizontally laid cladding
 - 2 Trapezoidal vertically laid cladding
 - 3 Trisobuild seam vertically laid cladding
 - 4 Flat horizontally laid feature cladding 1
 - 5 Flat horizontally laid feature cladding 2
 - 6 Rodeca cladding
 - 7 Green wall
 - 8 Profiled roof cladding system
 - 9 Brise soleil
 - 10 Curtain wall system
 - 11 Level access
 - 12 Personnel door
 - 13 Level access door canopy
 - 14 Canopy projection over office area
 - 15 Cantilevered balcony
 - 16 Translucent rooflight - 10%
 - 17 Roof access hatch
 - 18 Unit signage

P04	TR	SJP	SJP	17/07/23
Project name updated				
P03	EM	SJP	SJP	14/07/23
Elevations updated in line with building plans				
P02	EM	SJP	SJP	06/07/23
Elevations and level heads updated				
P01	EM	SJP	SJP	05/07/23
First issue				
Rev	Drawn By:	Checked By:	Approved By:	Date:
Amendments				
Project: Bridge Point Weybridge				
Title: Unit C Proposed Elevations				
Drawing Number: Identification / Location: Sheet Number: Project Code: Originator Vol / Zone: Level: Type: Role: Number: WEYB BED Z3 EL DR A 6303				
Rev Description: Preliminary		Status Code: S0	Model Ref: 0003	Rev No: P04
Scale: 1:200	Sheet: A1	Discipline: Architectural	BED Project Number: NWK 230040	
Client:				

PLANNING ISSUE

